
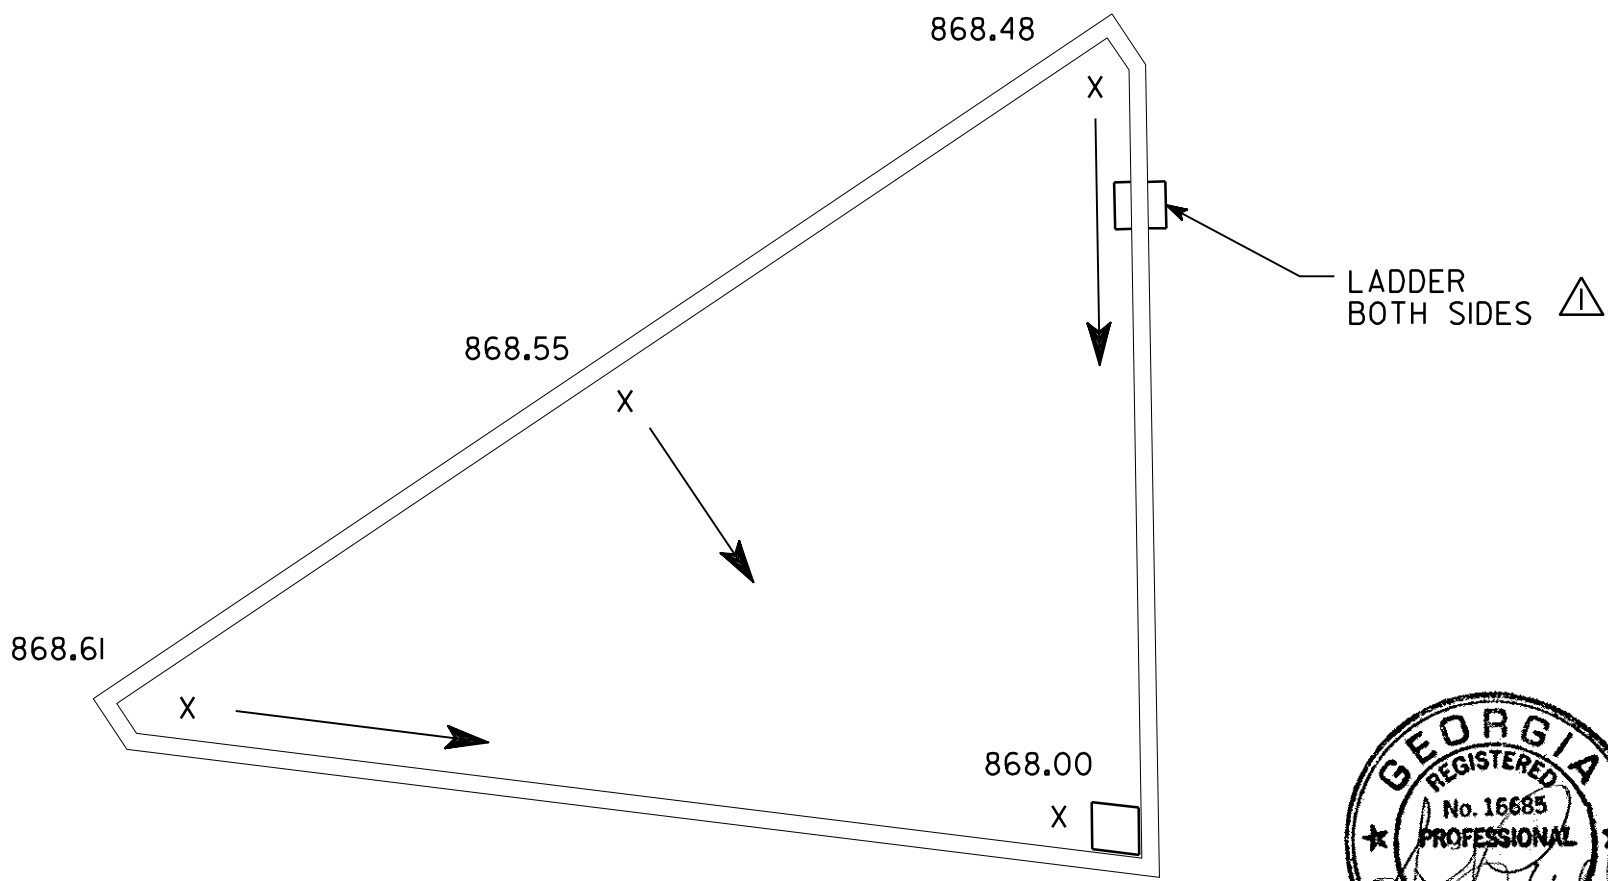


- GENERAL NOTES**
1. SPECIFICATIONS - GEORGIA STANDARD SPECIFICATIONS, 2013 EDITION, AS MODIFIED BY CONTRACT DOCUMENTS.
 2. DESIGN SPECIFICATIONS AASHTO 17TH EDITION, 2002
 3. REINFORCING STEEL - PLACE AND TIE ALL REINFORCING STEEL IN ACCORDANCE WITH THE GEORGIA DOT SPECIFICATIONS. DO NOT WELD REINFORCING STEEL.
 4. CHAMFER ALL EXPOSED CONCRETE EDGES $\frac{3}{4}$ " UNLESS OTHERWISE NOTED.
 5. DIMENSIONS AND ELEVATIONS - VERIFY ALL DIMENSIONS AND ELEVATIONS IN THE FIELD PRIOR TO ORDERING MATERIALS OR BUILDING FORMS.
 6. CONCRETE: SHALL BE CLASS A, $F'c = 3,000$ PSI
 7. REINFORCEMENT STEEL SHALL BE GRADE 60, $F_y = 60,000$ PSI
 8. BAR LAPS SHALL BE 60 BAR DIAMETERS MIN.
 9. BACKFILL SHALL BE COMPACTED TO 95% OF AASHTO T-99.
 10. SEE SITE PLANS FOR POND LAYOUT AND UTILITIES.
 11. CONTRACTION JOINTS SHALL BE PROVIDED IN FLOOR AT A MAXIMUM OF 20 FT. IN EACH DIRECTION. NO EXPANSION JOINTS ARE REQUIRED IN THE FLOOR.
 12. 1" EXPANSION JOINTS SHALL BE PROVIDED AT THE MIDPOINT OF EACH WALL AND CONTRACTION JOINTS AT 25 FT. SPACING.
 13. GDOT QPL WATER STOPS SHALL BE INSTALLED AT ALL EXPANSION AND CONTRACTION JOINTS.
 14. CONTRACTOR SHALL PROVIDE TEMPORARY SHORING AS NECESSARY FOR CONSTRUCTION OF THE FACILITY.
 15. PLACE 6" OF COMPACTED CRUSHER RUN PRIOR TO CONSTRUCTING THE CONCRETE FLOOR SLAB.
 16. EXPOSED CONCRETE SHALL RECEIVE A TYPE III RUBBED FINISH PER SECTION 500 OF THE GEORGIA DOT SPECIFICATIONS.

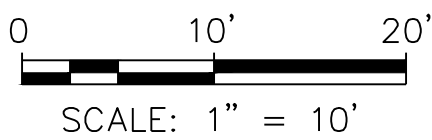

TOP OF FLOOR ELEVATIONS

LONG
ENGINEERING, INC.


LONG ENGINEERING, INC.
2550 HERITAGE COURT
SUITE 100
ATLANTA, GA 30339
770-951-2495



REVISIONS		
NO.	DATE	DESCRIPTION
△	3-23-15	ADDED NOTES 15 AND 16
△	3-23-15	ADDED LADDER

**WINDSOR PARKWAY DETENTION POND
STRUCTURAL NOTES & DETAILS**

**CITY OF
SANDY SPRINGS, GEORGIA**

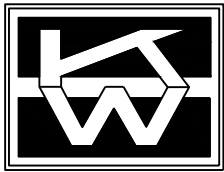

KECK & WOOD, INC.
2750 PREMIERE PARKWAY
SUITE 900
DULUTH, GEORGIA 30097
678-417-4000 FAX 678-417-4055

SCALE: AS SHOWN
DATE: 08/15/14
DWN: AH
CKD: SJS
PROJECT NO.: 140136

DRAWING NO.
S.1